

This drawing is copyright and the property of DMWA Ltd. It may not be copied reproduced or altered in any way without their written authority. Do not scale from this drawing, work to figured dimensions. All dimensions to be checked on site and any discrepancies reported to the Architect immediately. All structural and specialist elements/components/details, including glazing, are to be approved by the Structural Engineer or Specialist Contractor.


DESIGNERS RISK ASSESSMENT: HEALTH AND SAFETY THE CONSTRUCTION (DESIGN AND MANAGEMENT) REGULATIONS 2007

Building Products and Construction Execution Hazards

Common/everyday hazards associated with Building Products and Construction processes are not listed below and will be assumed to be controlled by the <u>Principal Contractor</u> following good safety, management and site practice procedures.

The proposed works are designed on a well established method of construction, which can be carried out by a competent contractor. However, should the contractor find any area of concern he must inform the designer immediately in order that appropriate action can be taken.

THESE DRAWINGS ARE FOR PLANNING PURPOSES ONLY AND ARE NOT FOR CONSTRUCTION

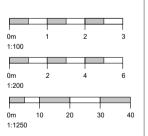

roject: Replacement Cafe Beach House Café The Spit Mudeford BH6 4EN

Client: K Slater

Drawing Title: Existing Site & Location Plans


Job No: 201004

Drawn: AR/RM
Date: 28.02.2025


Scale: As Indicated @ A3

Drawing No: PL201



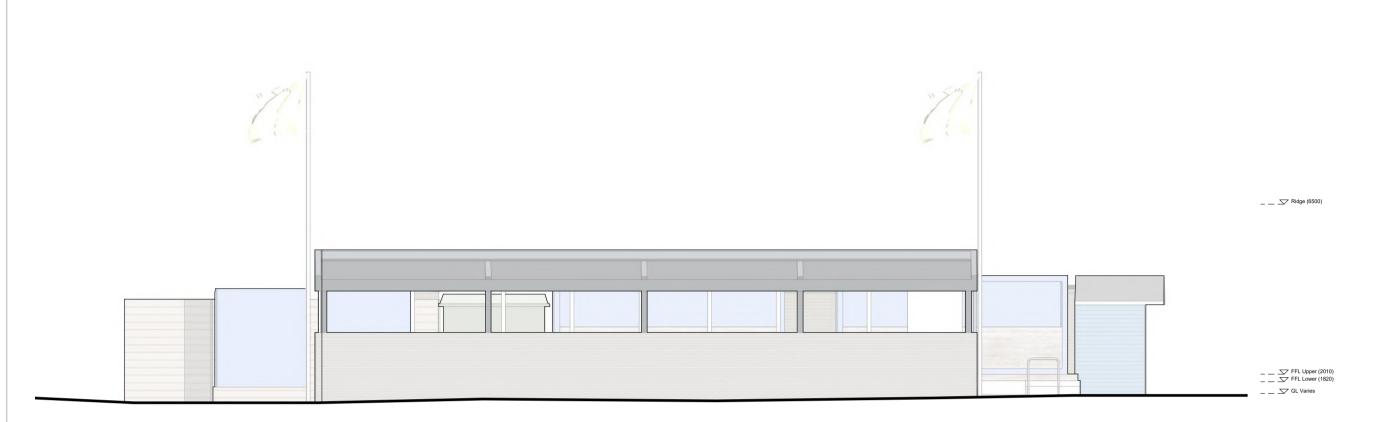

**Existing West Elevation** \_ \_ 🗢 000 1:100

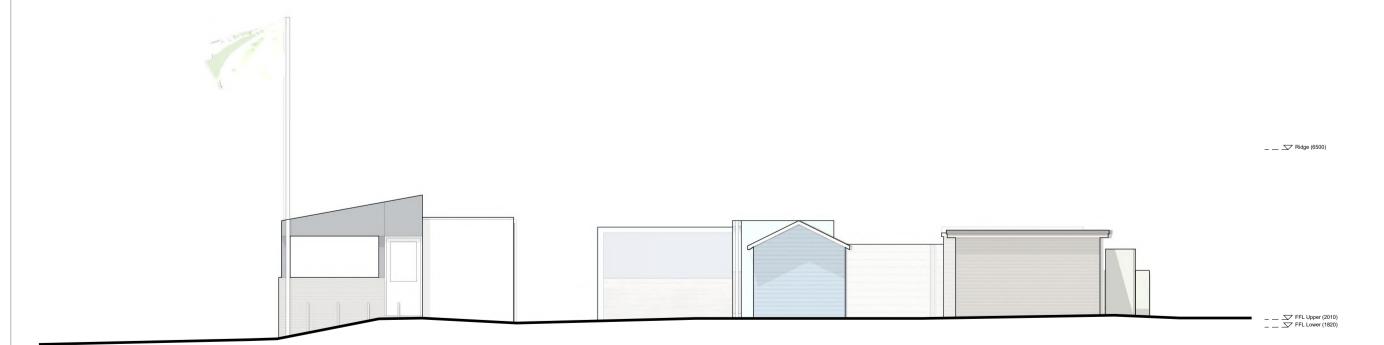

**Existing South Elevation** 

1:100 \_ \_ 🗢 🗸 000

# PLANNING

This drawing is copyright and the property of DMWA Ltd. It may not be copied reproduced or altered in any way without their written authority. Do not scale from this drawing, work to figured dimensions. All dimensions to be checked on site and any discrepancies reported to the Architect immediately. All structural and specialist elements/components/details, including glazing, are to be approved by the Structural Engineer or Specialist Contractor.


DESIGNERS RISK ASSESSMENT: HEALTH AND SAFETY THE CONSTRUCTION (DESIGN AND MANAGEMENT) REGULATIONS 2007

Building Products and Construction Execution Hazards

Common/everyday hazards associated with Building Products and Construction processes are not listed below and will be assumed to be controlled by the <u>Principal Contractor</u> following good safety, management and site practice procedures.

The proposed works are designed on a well established method of construction, which can be carried out by a competent contractor. However, should the contractor find any area of concern he must inform the designer immediately in order that appropriate action can be taken.

THESE DRAWINGS ARE FOR PLANNING PURPOSES ONLY AND ARE NOT FOR CONSTRUCTION

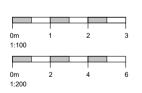

Replacement Cafe Beach House Café The Spit Mudeford BH6 4EN

K Slater Client:


Drawing Title: Existing Elevations

Job No: 201004 Drawn: AR/RM 28.02.2025 Date:

As Indicated @ A3 Scale:

Drawing No: PL202

architects

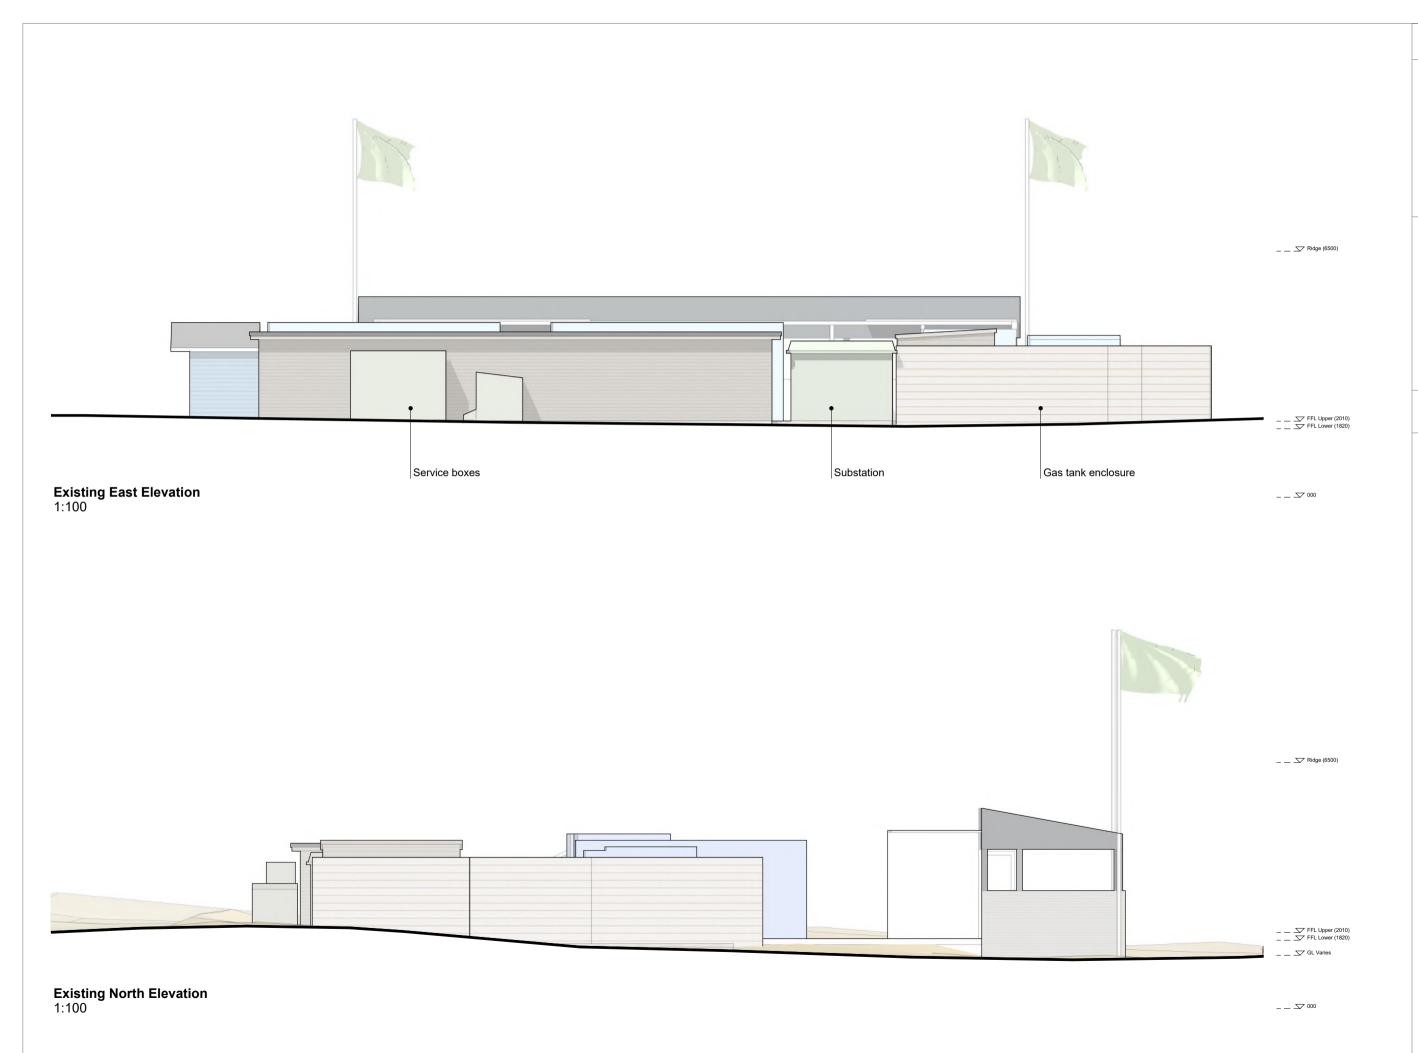

This drawing is copyright and the property of DMWA Ltd. It may not be copied reproduced or altered in any way without their written authority. Do not scale from this drawing, work to figured dimensions. All dimensions to be checked on site and any discrepancies reported to the Architect immediately. All structural and specialist elements/components/details, including glazing, are to be approved by the Structural Engineer or Specialist Contractor.


#### DESIGNERS RISK ASSESSMENT: HEALTH AND SAFETY THE CONSTRUCTION (DESIGN AND MANAGEMENT) REGULATIONS 2007

Building Products and Construction Execution Hazards

Common/everyday hazards associated with Building Products and Construction processes are not listed below and will be assumed to be controlled by the <u>Principal Contractor</u> following good safety, management and site practice procedures.

The proposed works are designed on a well established method of construction, which can be carried out by a competent contractor. However, should the contractor find any area of concern he must inform the designer immediately in order that appropriate action can be taken.

THESE DRAWINGS ARE FOR PLANNING PURPOSES ONLY AND ARE NOT FOR CONSTRUCTION

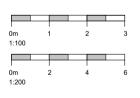

Project:

Replacement Cafe Beach House Café The Spit Mudeford BH6 4EN

Client: K Slater

Drawing Title: Existing Elevations

 Job No:
 201004


 Drawn:
 AR/RM

 Date:
 28.02.2025

Scale: As Indicated @ A3

Drawing No: PL203



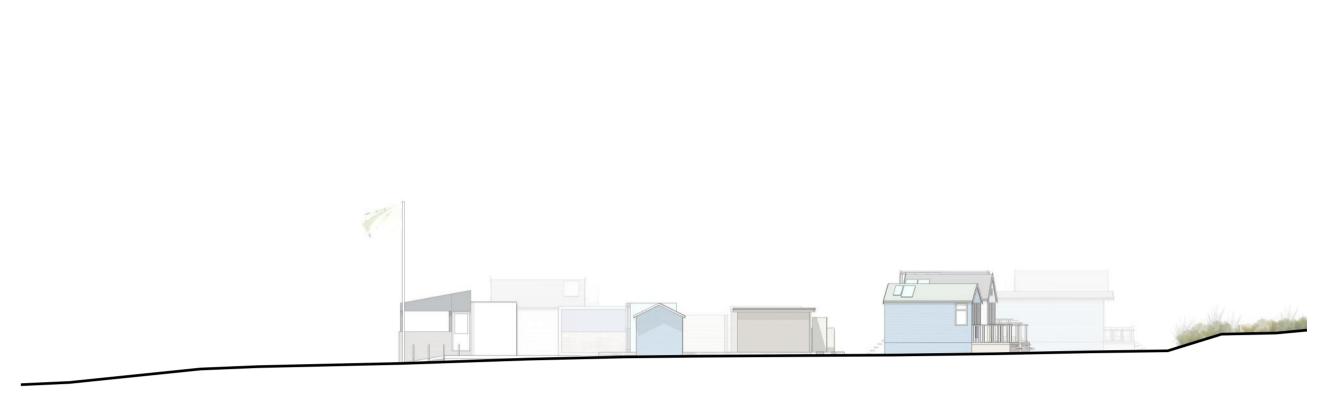

**Existing South Contextual Elevation** 1:200



**Existing West Contextual Elevation** 1:200

# PLANNING

This drawing is copyright and the property of DMWA Ltd. It may not be copied reproduced or altered in any way without their written authority. Do not scale from this drawing, work to figured dimensions. All dimensions to be checked on site and any discrepancies reported to the Architect immediately. All structural and specialist elements/components/details, including glazing, are to be approved by the Structural Engineer or Specialist Contractor.


# DESIGNERS RISK ASSESSMENT: HEALTH AND SAFETY THE CONSTRUCTION (DESIGN AND MANAGEMENT) REGULATIONS 2007

Building Products and Construction Execution Hazards

Common/everyday hazards associated with Building Products and Construction processes are not listed below and will be assumed to be controlled by the <u>Principal Contractor</u> following good safety, management and site practice procedures.

The proposed works are designed on a well established method of construction, which can be carried out by a competent contractor. However, should the contractor find any area of concern he must inform the designer immediately in order that appropriate action can be taken.

THESE DRAWINGS ARE FOR PLANNING PURPOSES ONLY AND ARE NOT FOR CONSTRUCTION

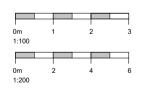

Replacement Cafe Beach House Café The Spit Mudeford BH6 4EN

K Slater Drawing Title: Existing Contextual Elevations

Job No: 201004 Drawn: AR/RM

28.02.2025 Date: As Indicated @ A3

Drawing No: PL204

architects

This drawing is copyright and the property of DMWA Ltd. It may not be copied reproduced or altered in any way without their written authority. Do not scale from this drawing, work to figured dimensions. All dimensions to be checked on site and any discrepancies reported to the Architect immediately. All structural and specialist elements/components/details, including glazing, are to be approved by the Structural Engineer or Specialist


DESIGNERS RISK ASSESSMENT: HEALTH AND SAFETY THE CONSTRUCTION (DESIGN AND MANAGEMENT) REGULATIONS 2007

Building Products and Construction Execution Hazards

Common/everyday hazards associated with Building Products and Construction processes are not listed below and will be assumed to be controlled by the <u>Principal Contractor</u> following good safety, management and site practice procedures.

The proposed works are designed on a well established method of construction, which can be carried out by a competent contractor. However, should the contractor find any area of concern he must inform the designer immediately in order that appropriate action can be taken.

THESE DRAWINGS ARE FOR PLANNING PURPOSES ONLY AND ARE NOT FOR CONSTRUCTION

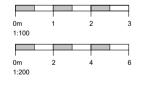

r roject.

The Spit Mudeford BH6 4EN

Client: K Slater

Drawing Title: Proposed Site Plan

Job No: 201004

Drawn: AR/RM

Date: 28.02.2025

Scale: As Indicated @ A3

Drawing No: PL205

DMW architects

01202 884024 www.dmwa.co.uk

Site Plan

1:200

### **Key Design Principles**

A simple and recognisable form, modest in scale, presenting a clear and uncluttered building for all users to enjoy

\*Accessible for all

\*Building with a clear identity and sense of place

\*Recognisable form harmonises with setting and character of site

\*Unified and uncluttered visual appearance

\*Facing materials will be robust and low maintenance

\*Lightweight and modular construction

\*Minimise physical and environmental impact

\*Harness solar energy and natural daylight

\*Enhanced privacy and outlook for nearby beach hut residents

\*Perimeter dune grasses to promote stability and living roof to encourage wildlife

\*Positive asset for all visitors

### **Typical Construction**

A modular building from pre made components, constructed off site to minimise time, noise, cost and construction traffic

\*Pre cast concrete piles with modular galvanised steel frame set over

\*Modular wall and roof panels around shipping container modules

\*Non combustible, pre weathered materials

\*Robust roofing material and rainwater goods



### PLANNING

This drawing is copyright and the property of DMWA Ltd. It may not be copied reproduced or altered in any way without their written authority. Do not scale from this drawing, work to figured dimensions. All dimensions to be checked on site and any discrepancies reported to the Architect immediately. All structural and specialist elements/components/details, including glazing, are to be approved by the Structural Engineer or Specialist


DESIGNERS RISK ASSESSMENT: HEALTH AND SAFETY THE CONSTRUCTION (DESIGN AND MANAGEMENT) REGULATIONS 2007

Building Products and Construction Execution Hazards

Commonleveryday hazards associated with Building Products and Construction processes are not listed below and will be assumed to be contilled by the Principal Contractor following good safety, management and site practice procedures.

The proposed works are designed on a well established method of construction, which can be carried out by a competent contractor. However, should the contractor find any area of concern he must inform the designer immediately in order that appropriate action can be taken.

THESE DRAWINGS ARE FOR PLANNING PURPOSES ONLY AND ARE NOT FOR CONSTRUCTION

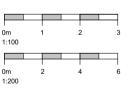

Project: R B T

BH6 4EN

Client: K Slater

Drawing Title: Proposed Floor Plan

 Job No:
 201004

 Drawn:
 AR/RM

 Date:
 28.02.2025


Scale: As Indicated @ A3


Drawing No: PL206



01202 884024 www.dmwa.co.uk

Proposed Floor Plan 1:100

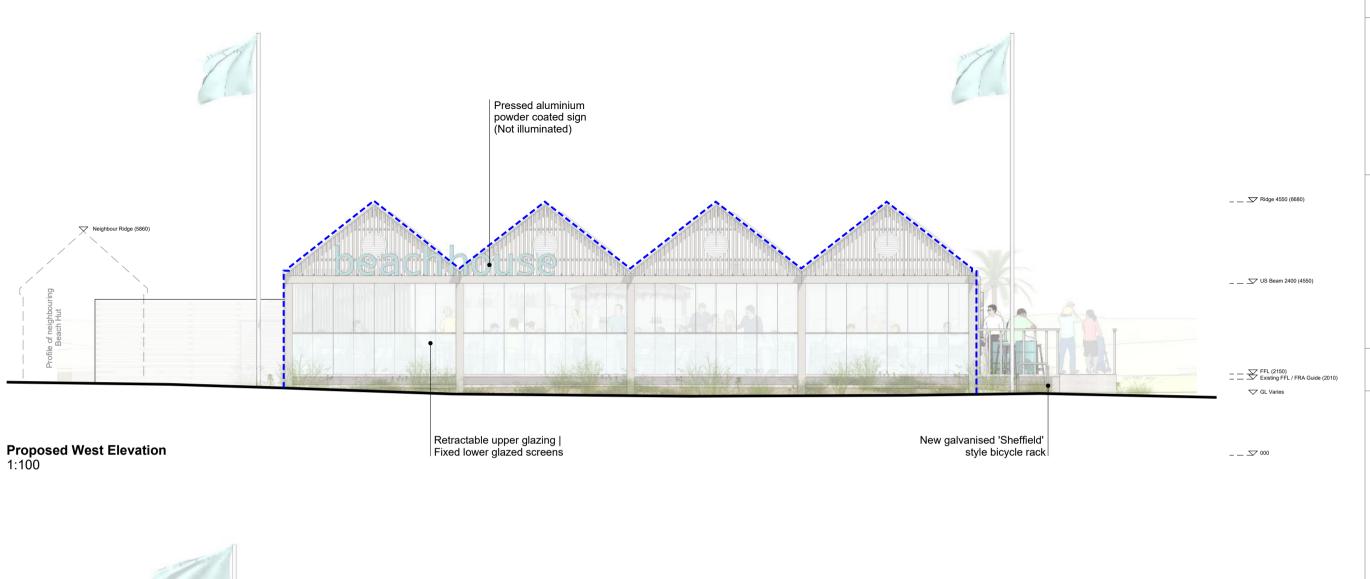

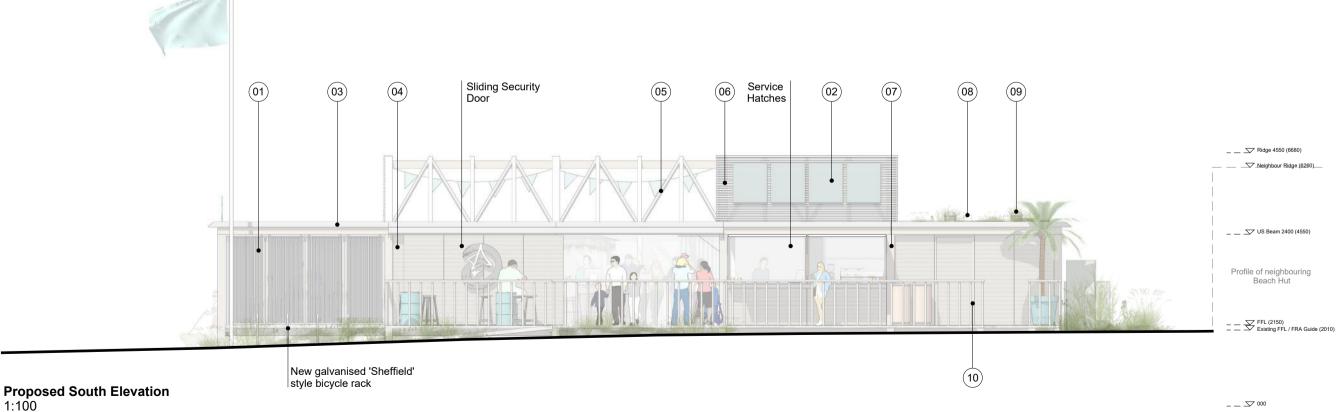

This drawing is copyright and the property of DMWA Ltd. It may not be copied reproduced or altered in any way without their written authority. Do not scale from this drawing, work to figured dimensions. All dimensions to be checked on site and any discrepancies reported to the Architect immediately. All structural and specialist elements/components/details, including glazing, are to be approved by the Structural Engineer or Specialist

DESIGNERS RISK ASSESSMENT: HEALTH AND SAFETY THE CONSTRUCTION (DESIGN AND MANAGEMENT) REGULATIONS 2007

Building Products and Construction Execution Hazards

Common/everyday hazards associated with Building Products and Construction processes are not listed below and will be assumed to be controlled by the <u>Principal Contractor</u> following good safety, management and site practice procedures.


The proposed works are designed on a well THE PROPUSED WORKS are designed on a well established method of construction, which can be carried out by a competent contractor. However, should the contractor find any area of concern he must inform the designer immediately in order that appropriate action can be taken.

THESE DRAWINGS ARE FOR PLANNING PURPOSES ONLY AND ARE NOT FOR CONSTRUCTION

#### Materials

- 01 PPC aluminium fixed angle privacy fins mid grey colour
- 02 PV panels matt finish
- 03 PPC aluminium rainwater goods mid grey colour
- 04 Fibre cementitious cladding strips silver oak colour
- 05 Expressed open timber roof skeleton 06 Feather edge timber open spaced
- 07 Expressed timber frame
- 08 Green roof | Sea hardened durable sedum mix in llightweight growing medium over EPDM roof
- 09 Flat roof sun tunnel
- 10 Timber balustrade

### Approved building profile App 7-2022-11229-P

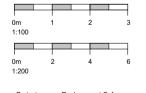

Replacement Cafe Beach House Café The Spit Mudeford BH6 4EN


K Slater Client:


Drawing Title: Proposed Elevations 201004 Job No:

AR/RM Drawn: Date: 28.02.2025 Scale: As Indicated @ A3

Drawing No: PL207



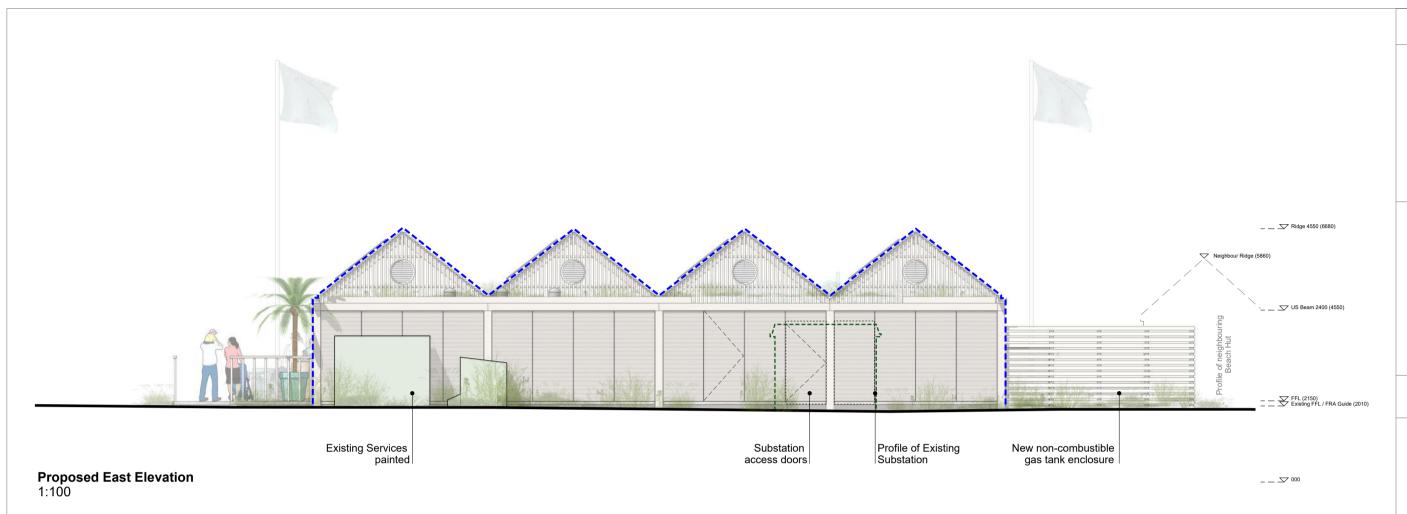

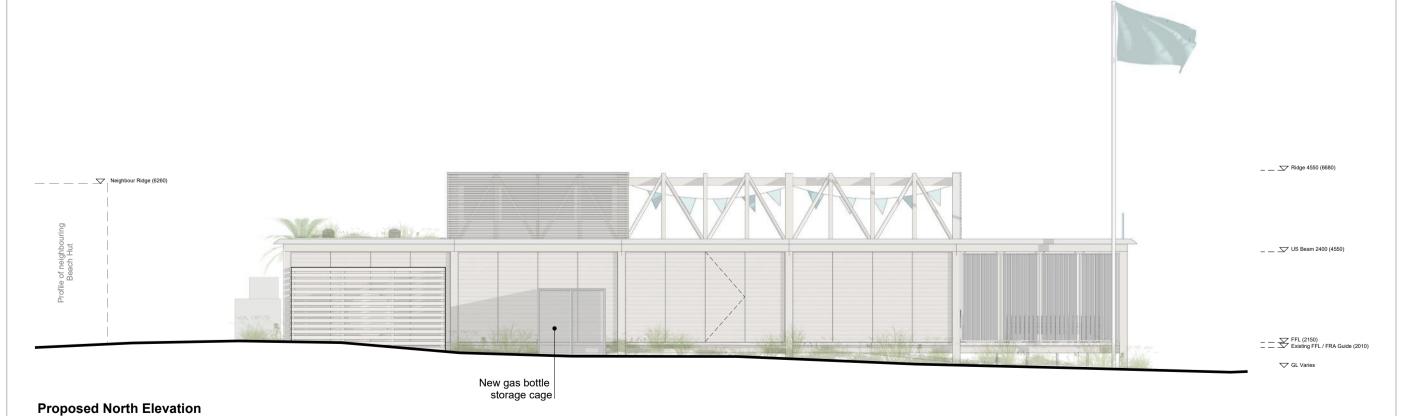

1:100

# PLANNING

This drawing is copyright and the property of DMWA Ltd. It may not be copied reproduced or altered in any way without their written authority. Do not scale from this drawing, work to figured dimensions. All dimensions to be checked on site and any discrepancies reported to the Architect immediately. All structural and specialist elements/components/details, including glazing, are to be approved by the Structural Engineer or Specialist Contractor.

DESIGNERS RISK ASSESSMENT: HEALTH AND SAFETY THE CONSTRUCTION (DESIGN AND MANAGEMENT) REGULATIONS 2007


Building Products and Construction Execution Hazards

Common/everyday hazards associated with Building Products and Construction processes are not listed below and will be assumed to be controlled by the <u>Principal Contractor</u> following good safety, management and site practice procedures.

The proposed works are designed on a well established method of construction, which can be carried out by a competent contractor. However, should the contractor find any area of concern he must inform the designer immediately in order that appropriate action can be taken.

THESE DRAWINGS ARE FOR PLANNING PURPOSES ONLY AND ARE NOT FOR CONSTRUCTION

Approved building profile App 7-2022-11229-P

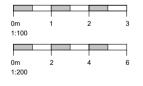

Project: Replacement Cafe Beach House Café The Spit Mudeford BH6 4EN

Client: K Slater

Drawing Title: Proposed Elevations


Job No: 201004

Drawn: AR/RM
Date: 28.02.2025
Scale: As Indicated @ A3


Drawing No: PL208

Rev:



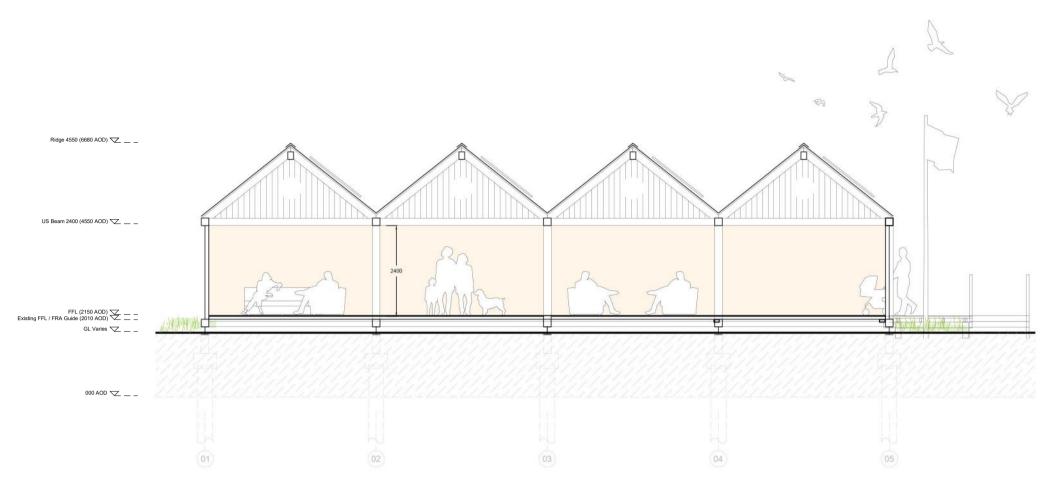

# **Proposed Typical Cross Section** - AA 1:100

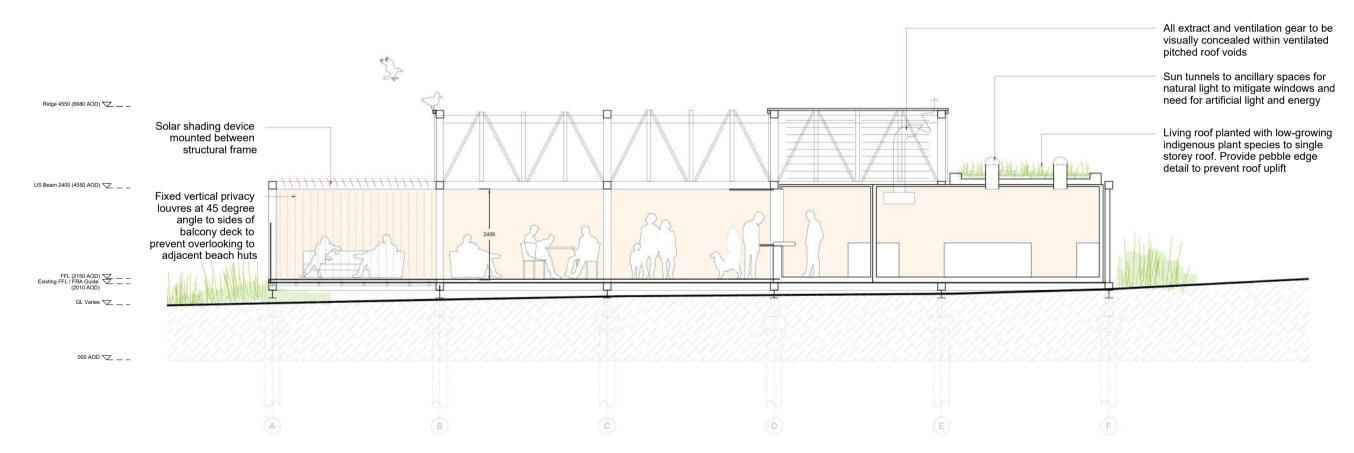

**Proposed Typical Long Section** - BB 1:100

## PLANNING

This drawing is copyright and the property of DMWA Ltd. It may not be copied reproduced or altered in any way without their written authority. Do not scale from this drawing, work to figured dimensions. All dimensions to be checked on site and any discrepancies reported to the Architect immediately. All structural and specialist elements/components/details, including glazing, are to be approved by the Structural Engineer or Specialist Contractor.


DESIGNERS RISK ASSESSMENT: HEALTH AND SAFETY THE CONSTRUCTION (DESIGN AND MANAGEMENT) REGULATIONS 2007

Building Products and Construction Execution Hazards

Common/everyday hazards associated with Building Products and Construction processes are not listed below and will be assumed to be controlled by the <u>Principal Contractor</u> following good safety, management and site practice procedures.

The proposed works are designed on a well established method of construction, which can be carried out by a competent contractor. However, should the contractor find any area of concern he must inform the designer immediately in order that appropriate action can be taken.

THESE DRAWINGS ARE FOR PLANNING PURPOSES ONLY AND ARE NOT FOR CONSTRUCTION

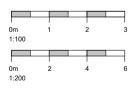

Project:

Beach House Cafe The Spit Mudeford BH6 4EN

Ciletti.

Drawing Title: Proposed Sections

K Slater

 Job No:
 201004

 Drawn:
 AR/RM

 Date:
 28.02.2025

Scale: As Indicated @ A3

Drawing No: PL209


-

DMW architects

01202 884024 www dmwa co uk



**Proposed South Contextual Elevation** 1:200

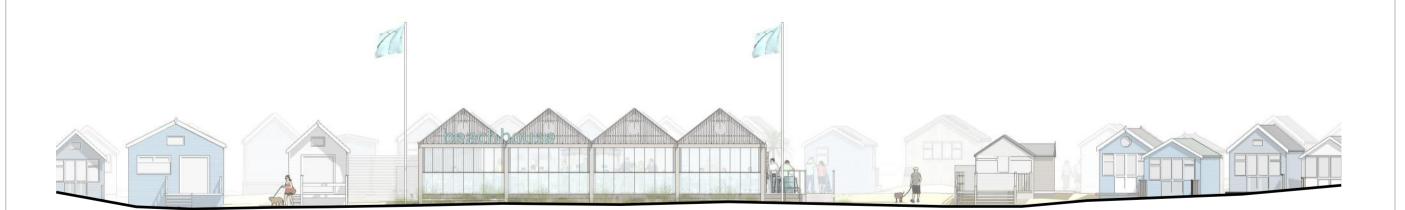

**Proposed West Contextual Elevation** 1:200

# PLANNING

This drawing is copyright and the property of DMWA Ltd. It may not be copied reproduced or altered in any way without their written authority. Do not scale from this drawing, work to figured dimensions. All dimensions to be checked on site and any discrepancies reported to the Architect immediately. All structural and specialist elements/components/details, including glazing, are to be approved by the Structural Engineer or Specialist


# DESIGNERS RISK ASSESSMENT: HEALTH AND SAFETY THE CONSTRUCTION (DESIGN AND MANAGEMENT) REGULATIONS 2007

Building Products and Construction Execution Hazards

Common/everyday hazards associated with Building Products and Construction processes are not listed below and will be assumed to be controlled by the <u>Principal Contractor</u> following good safety, management and site practice procedures.

The proposed works are designed on a well established method of construction, which can be carried out by a competent contractor. However, should the contractor find any area of concern he must inform the designer immediately in order that appropriate action can be taken.

THESE DRAWINGS ARE FOR PLANNING PURPOSES ONLY AND ARE NOT FOR CONSTRUCTION

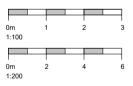

Replacement Cafe Beach House Café The Spit Mudeford BH6 4EN K Slater

Job No: 201004 Drawn: AR/RM 28.02.2025 Date:

As Indicated @ A3

Drawing No: PL210



This drawing is copyright and the property of DMWA Ltd. It may not be copied reproduced or altered in any way without their written authority. Do not scale from this drawing, work to figured dimensions. All dimensions to be checked on site and any discrepancies reported to the Architect immediately. All structural and specialist elements/components/details, including glazing, are to be approved by the Structural Engineer or Specialist Contractor.

Gas Tank

DESIGNERS RISK ASSESSMENT: HEALTH AND SAFETY THE CONSTRUCTION (DESIGN AND MANAGEMENT) REGULATIONS 2007

Building Products and Construction Execution Hazards

Common/everyday hazards associated with Building Products and Construction processes are not listed below and will be assumed to be controlled by the <u>Principal Contractor</u> following good safety, management and site practice procedures.

The proposed works are designed on a well established method of construction, which can be carried out by a competent contractor. However, should the contractor find any area of concern he must inform the designer immediately in order that appropriate action can be taken.

THESE DRAWINGS ARE FOR PLANNING PURPOSES ONLY AND ARE NOT FOR CONSTRUCTION

0m 1 2 3 1:100 0m 2 4 6 1:200

> Project: Replacen Beach Ho The Spit

Mudeford BH6 4EN

Drawing Title: Proposed Floor Areas

Drawing Title: Proposed Floor Areas

K Slater

Drawn: AR/RM
Date: 28.02.2025

Scale: As Indicated @ A3

Drawing No: PL211

Rev:

Client:

DMW architects

1202 884024 www.dmwa.co.uk

A — Metal Gas Fire Cylinder Cage Escape (2)-External WC& Covered Chy Store Privacy Store Screens Vetetetetek Store (S)-Elec Sub Station F.e.i.A. **टा**न्वंशङ / Fire Savary Escape (3) Franzer Orda Point Kitchen. (2) 8-'Sheffield' Style Bike Rack Inclusive Access Ramp  $\stackrel{\downarrow}{\bigcirc}$ E F

**Proposed Floor Plan** 

1:100

N

Proposed Internal Restaurant

Proposed External Covered

Proposed Services, Store, Shop

Restaurant Seating Area

Proposed Takeaway Area

Floorspace

& Kitchen Area

72m<sup>2</sup>

65m<sup>2</sup>

Total Area - 371m<sup>2</sup>

GFA - 410m<sup>2</sup>

This drawing is copyright and the property of DMWA Ltd. It may not be copied reproduced or altered in any way without their written authority. Do not scale from this drawing, work to figured dimensions. All dimensions to be checked on site and any discrepancies reported to the Architect immediately. All structural and specialist elements/components/details, including glazing, are to be approved by the Structural Engineer or Specialist Contractor.

DESIGNERS RISK ASSESSMENT: HEALTH AND SAFETY THE CONSTRUCTION (DESIGN AND MANAGEMENT) REGULATIONS 2007

Building Products and Construction Execution Hazards

Common/everyday hazards associated with Building Products and Construction processes are not listed below and will be assumed to be controlled by the <u>Principal Contractor</u> following good safety, management and site practice procedures.

The proposed works are designed on a well established method of construction, which can be carried out by a competent contractor. However, should the contractor find any area of concern he must inform the designer immediately in order that appropriate action can be taken.

THESE DRAWINGS ARE FOR PLANNING PURPOSES ONLY AND ARE NOT FOR CONSTRUCTION

0m 1:200

Replacement Cafe Beach House Café The Spit Mudeford BH6 4EN

K Slater

Drawing Title: Like for Like Floor Plan Areas

Job No: 201004 Drawn: AR/RM Date: 28.02.2025

Scale: As Indicated @ A3 Drawing No: PL212

architects

Store Sub station Kitchen Œ Café / Restaurant Store -----

External Covered Restaurant Seating Area 61m<sup>2</sup>

Internal Restaurant Floorspace

Services, Store, Shop & Kitchen 233m<sup>2</sup>

Total Area - 382m<sup>2</sup>

88m<sup>2</sup>

'Like for Like' Floor Plan 1:100